



GREEN RIVER COTTAGES


584 WATER STREET WILLIAMSTOWN, MA

ISSUED FOR REVIEW ONLY

Architect Stone Architecture, LLC 160 Water Street Williamstown, MA 01267 212.645.0635 Tel 212.645.1282 Fax

21 UNIT SITE PLAN

Drawing Title	9		
Drawn By		C	400
Approved By		S-100	
Issued For	REVIEW	Drawing No.	
Date	AUGUST 3, 2022	Scale	1/32" = 1'-0"

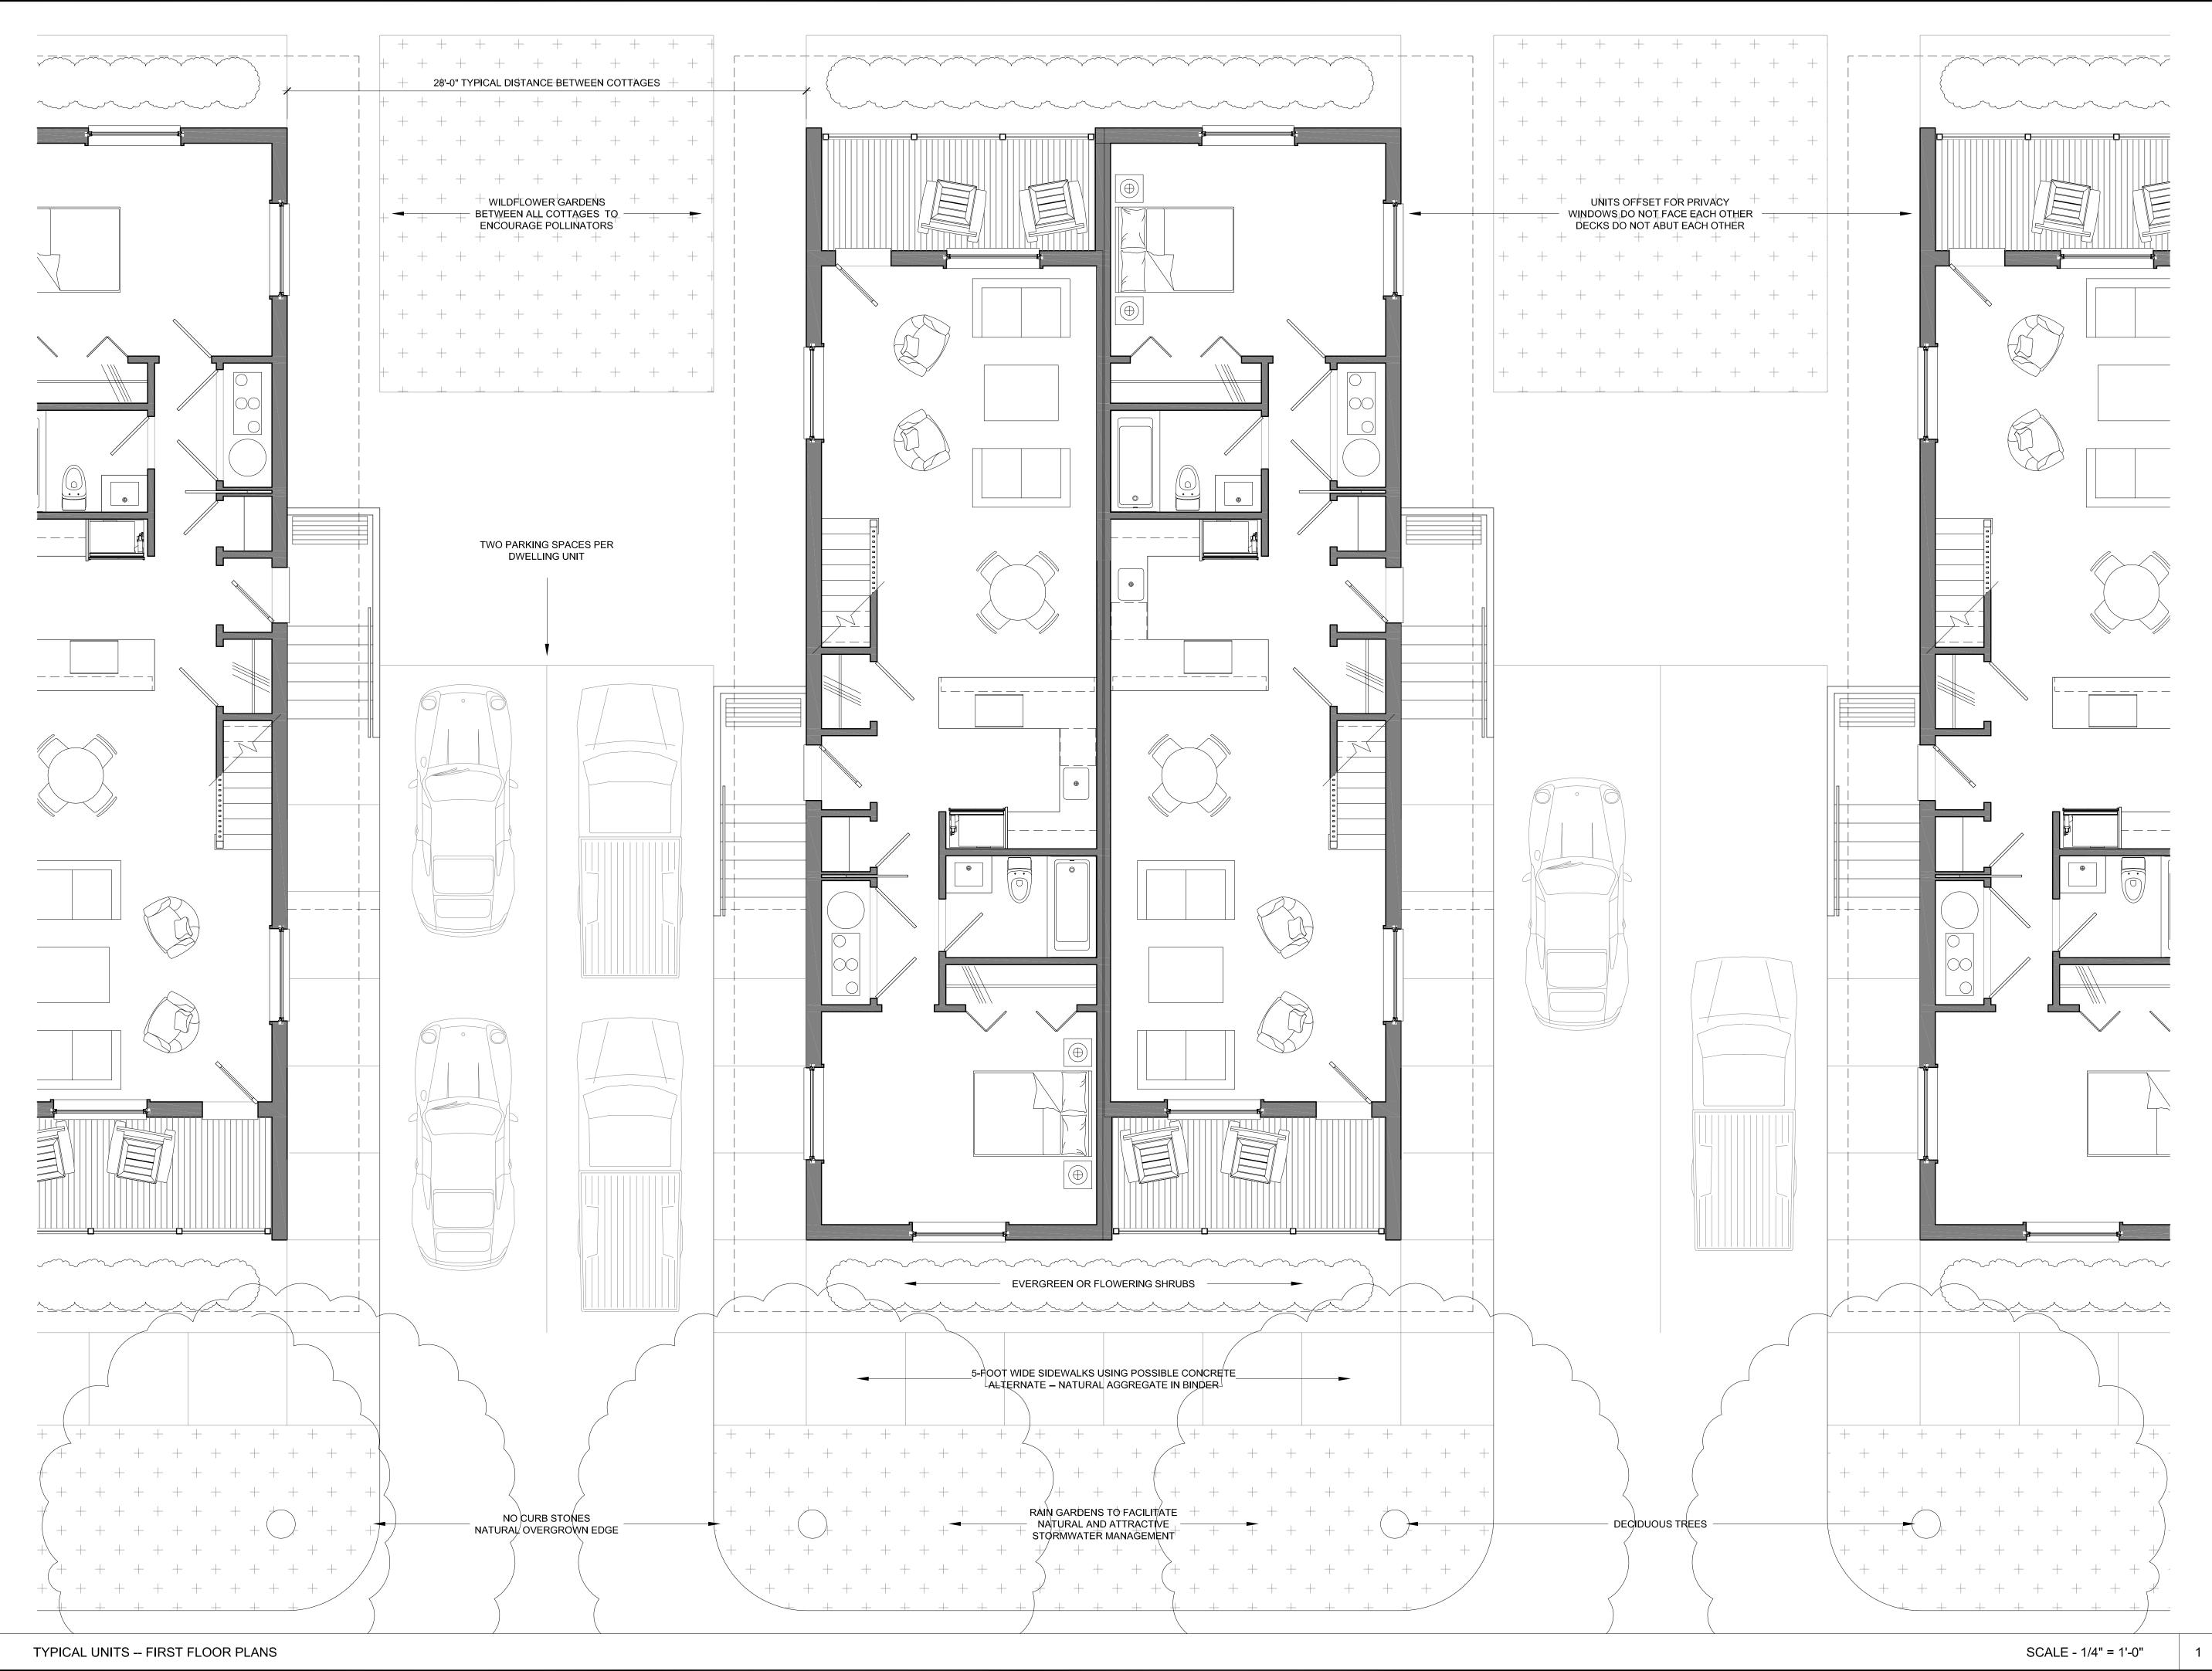

DPYRIGHT 2022, STONE ARCHITECTURE LLC, ALL RIGHTS RESERV



GREEN RIVER COTTAGES

584 WATER STREET WILLIAMSTOWN, MA

ISSUED FOR REVIEW ONLY

Architect Stone Architecture, LLC 160 Water Street Williamstown, MA 01267 212.645.0635 Tel 212.645.1282 Fax


No. Revision

SITE PLAN DETAIL

Drawing Title)		
Drawn By Approved By		S-101	
Date	AUGUST 3, 2022	Scale	1/4" = 1'-0"



COPYRIGHT 2022, STONE ARCHITECTURE LLC, ALL RIGHTS RES

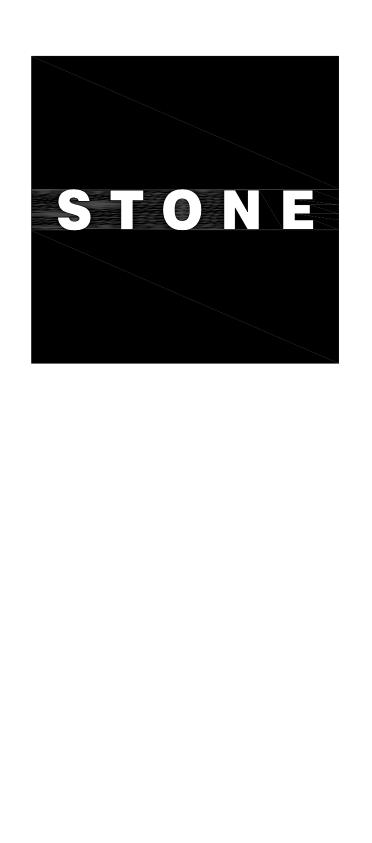

GREEN RIVER COTTAGES

584 WATER STREET WILLIAMSTOWN, MA

ISSUED FOR REVIEW ONLY

Architect Stone Architecture, LLC 160 Water Street Williamstown, MA 01267 212.645.0635 Tel 212.645.1282 Fax

1

No. Revision

TYPICAL DUPLEX UNIT FLOOR PLANS


 Drawing Title

 Drawn By
 A-100

 Approved By
 Drawing No.

 Issued For
 REVIEW
 Drawing No.

 Date
 AUGUST 3, 2022
 Scale
 1/4" = 1'-0"

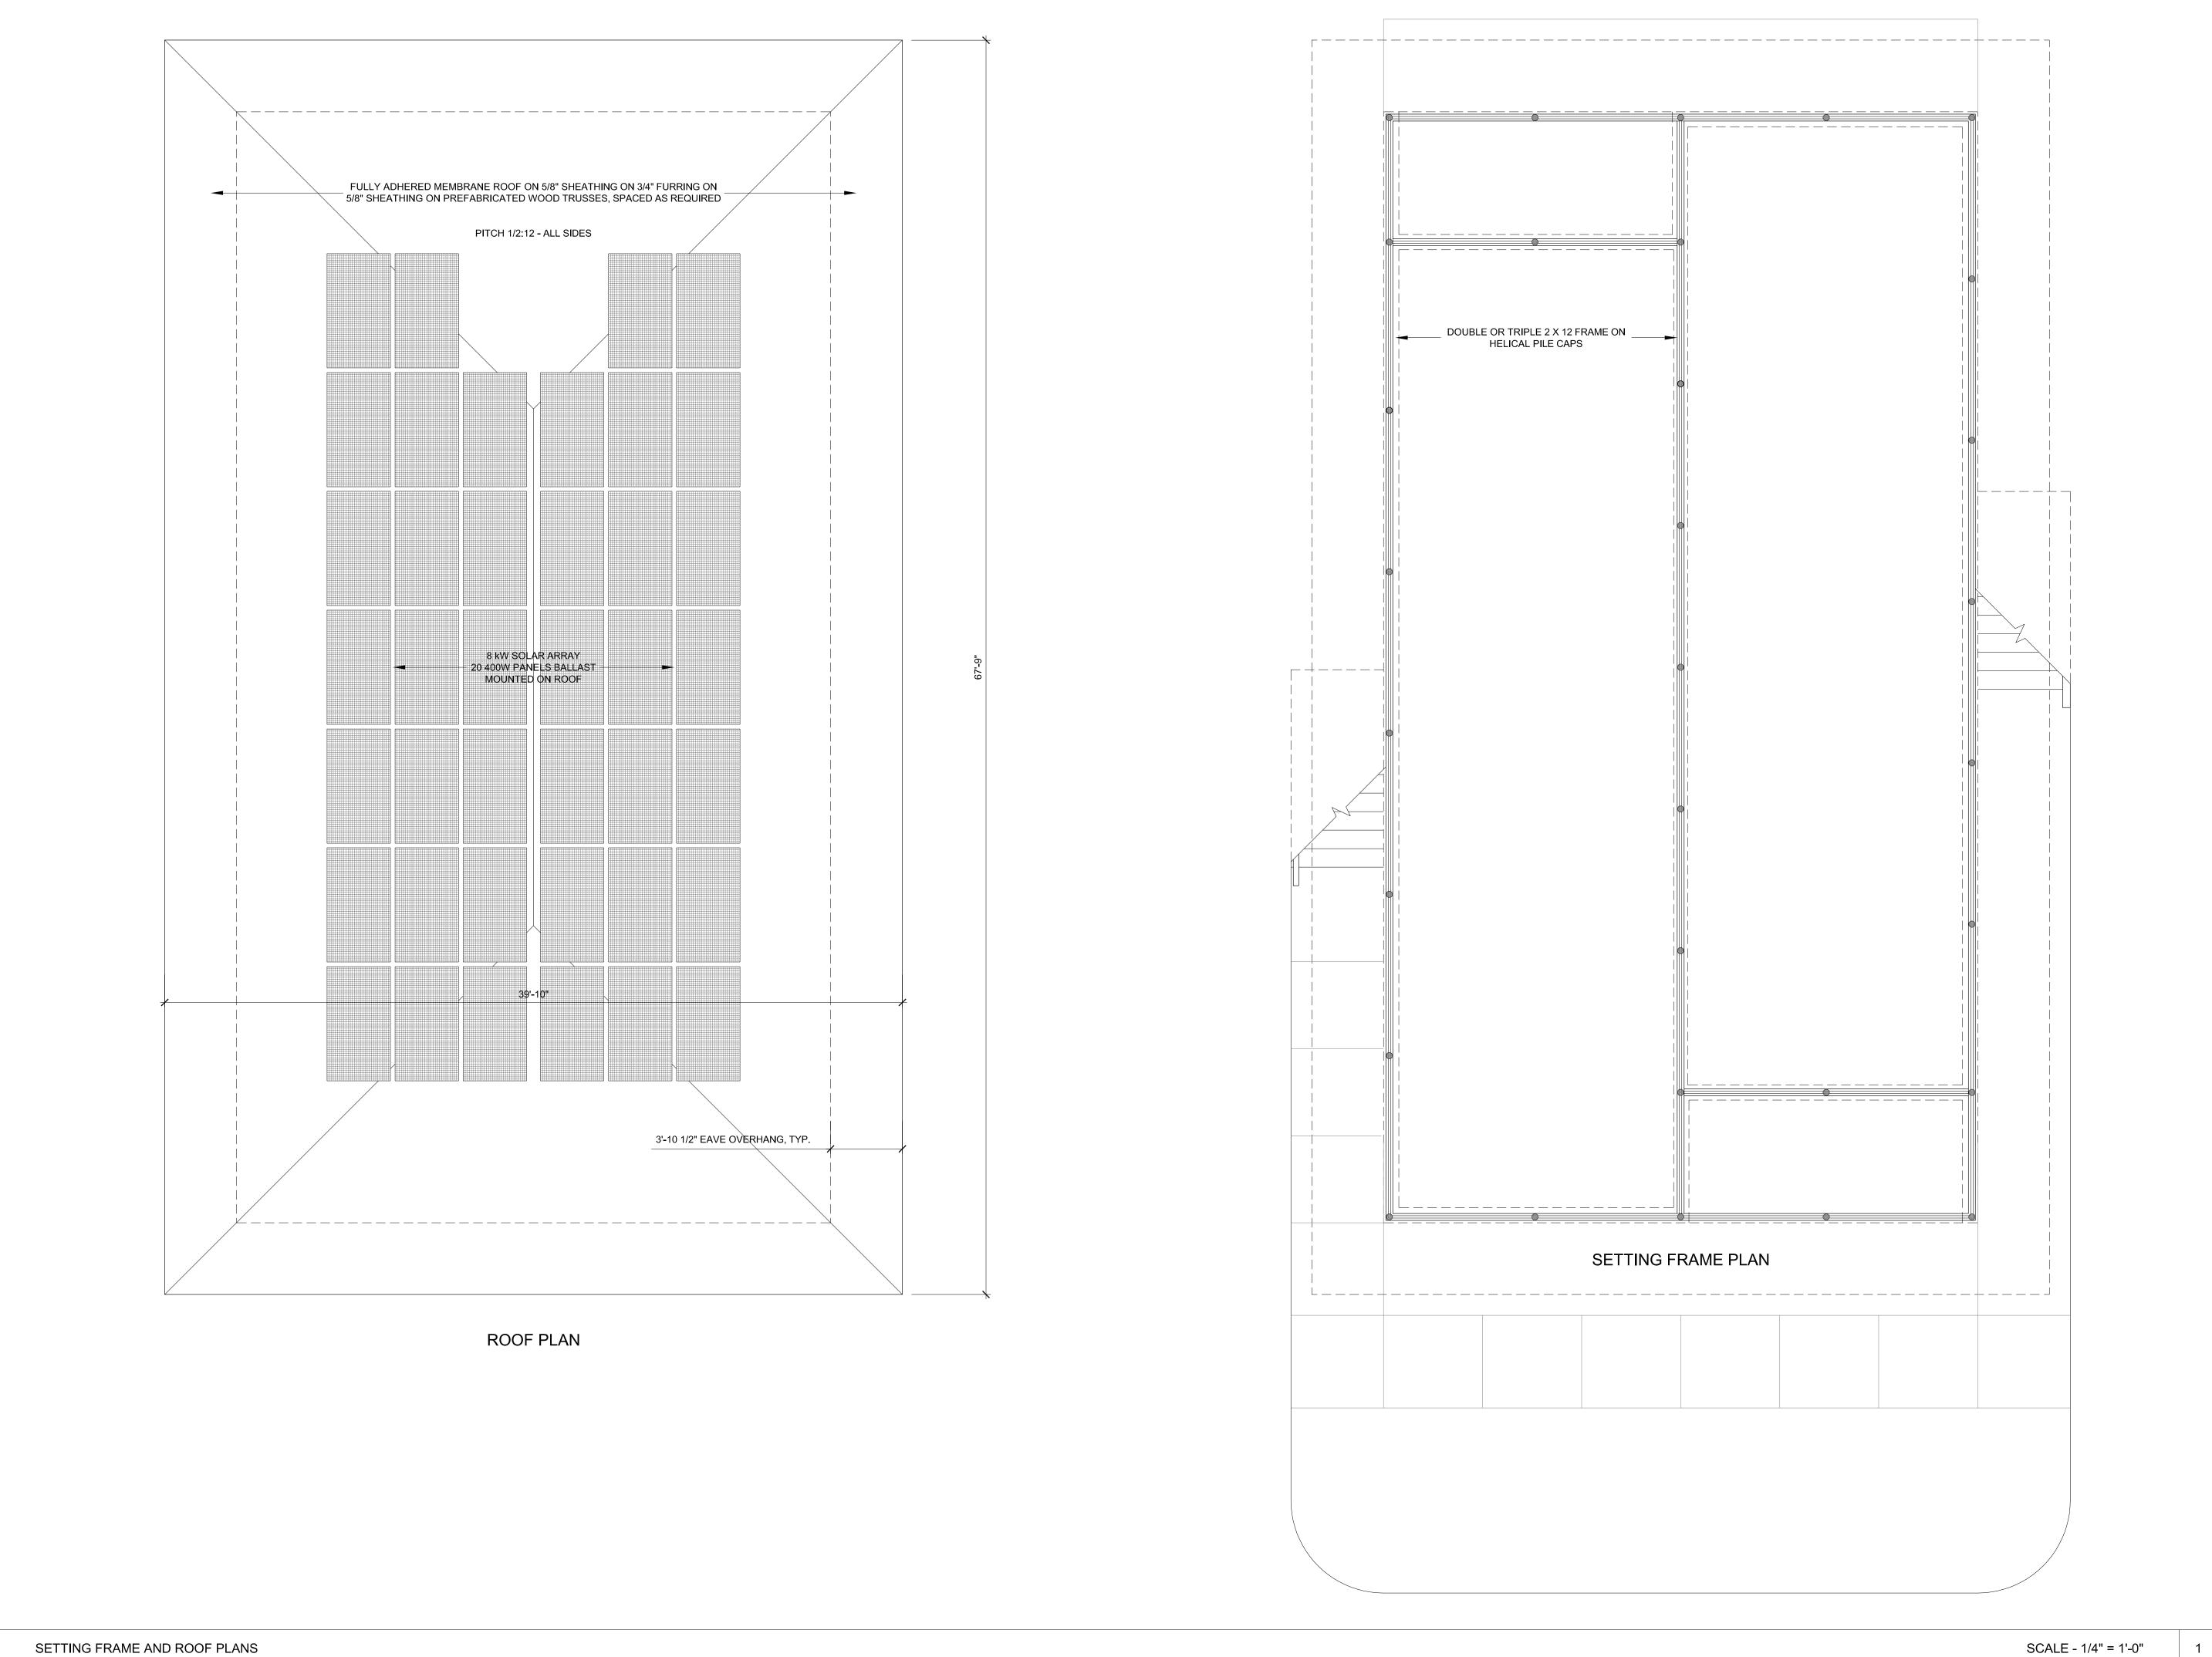

SETTING FRAME AND ROOF PLANS



GREEN RIVER COTTAGES

584 WATER STREET WILLIAMSTOWN, MA

ISSUED FOR REVIEW ONLY

Architect Stone Architecture, LLC 160 Water Street Williamstown, MA 01267 212.645.0635 Tel 212.645.1282 Fax

No. Revision

SETTING FRAME AND ROOF PLANS

Drawn By		٨	404
Approved By		A-101	
Issued For	REVIEW	Drawing No.	
Date	AUGUST 3, 2022	Scale	1/4" = 1'-0"





GREEN RIVER COTTAGES

Date

584 WATER STREET WILLIAMSTOWN, MA

ISSUED FOR REVIEW ONLY


Architect Stone Architecture, LLC 160 Water Street Williamstown, MA 01267 212.645.0635 Tel 212.645.1282 Fax

No. Revision

TYPICAL ELEVATIONS

Drawing Title)		
Drawn By		٨	400
Approved By		A-102	
Issued For	REVIEW	Drawing No.	
Date	AUGUST 3, 2022	Scale	1/4" = 1'-0"

SCALE - 1/4" = 1'-0"	

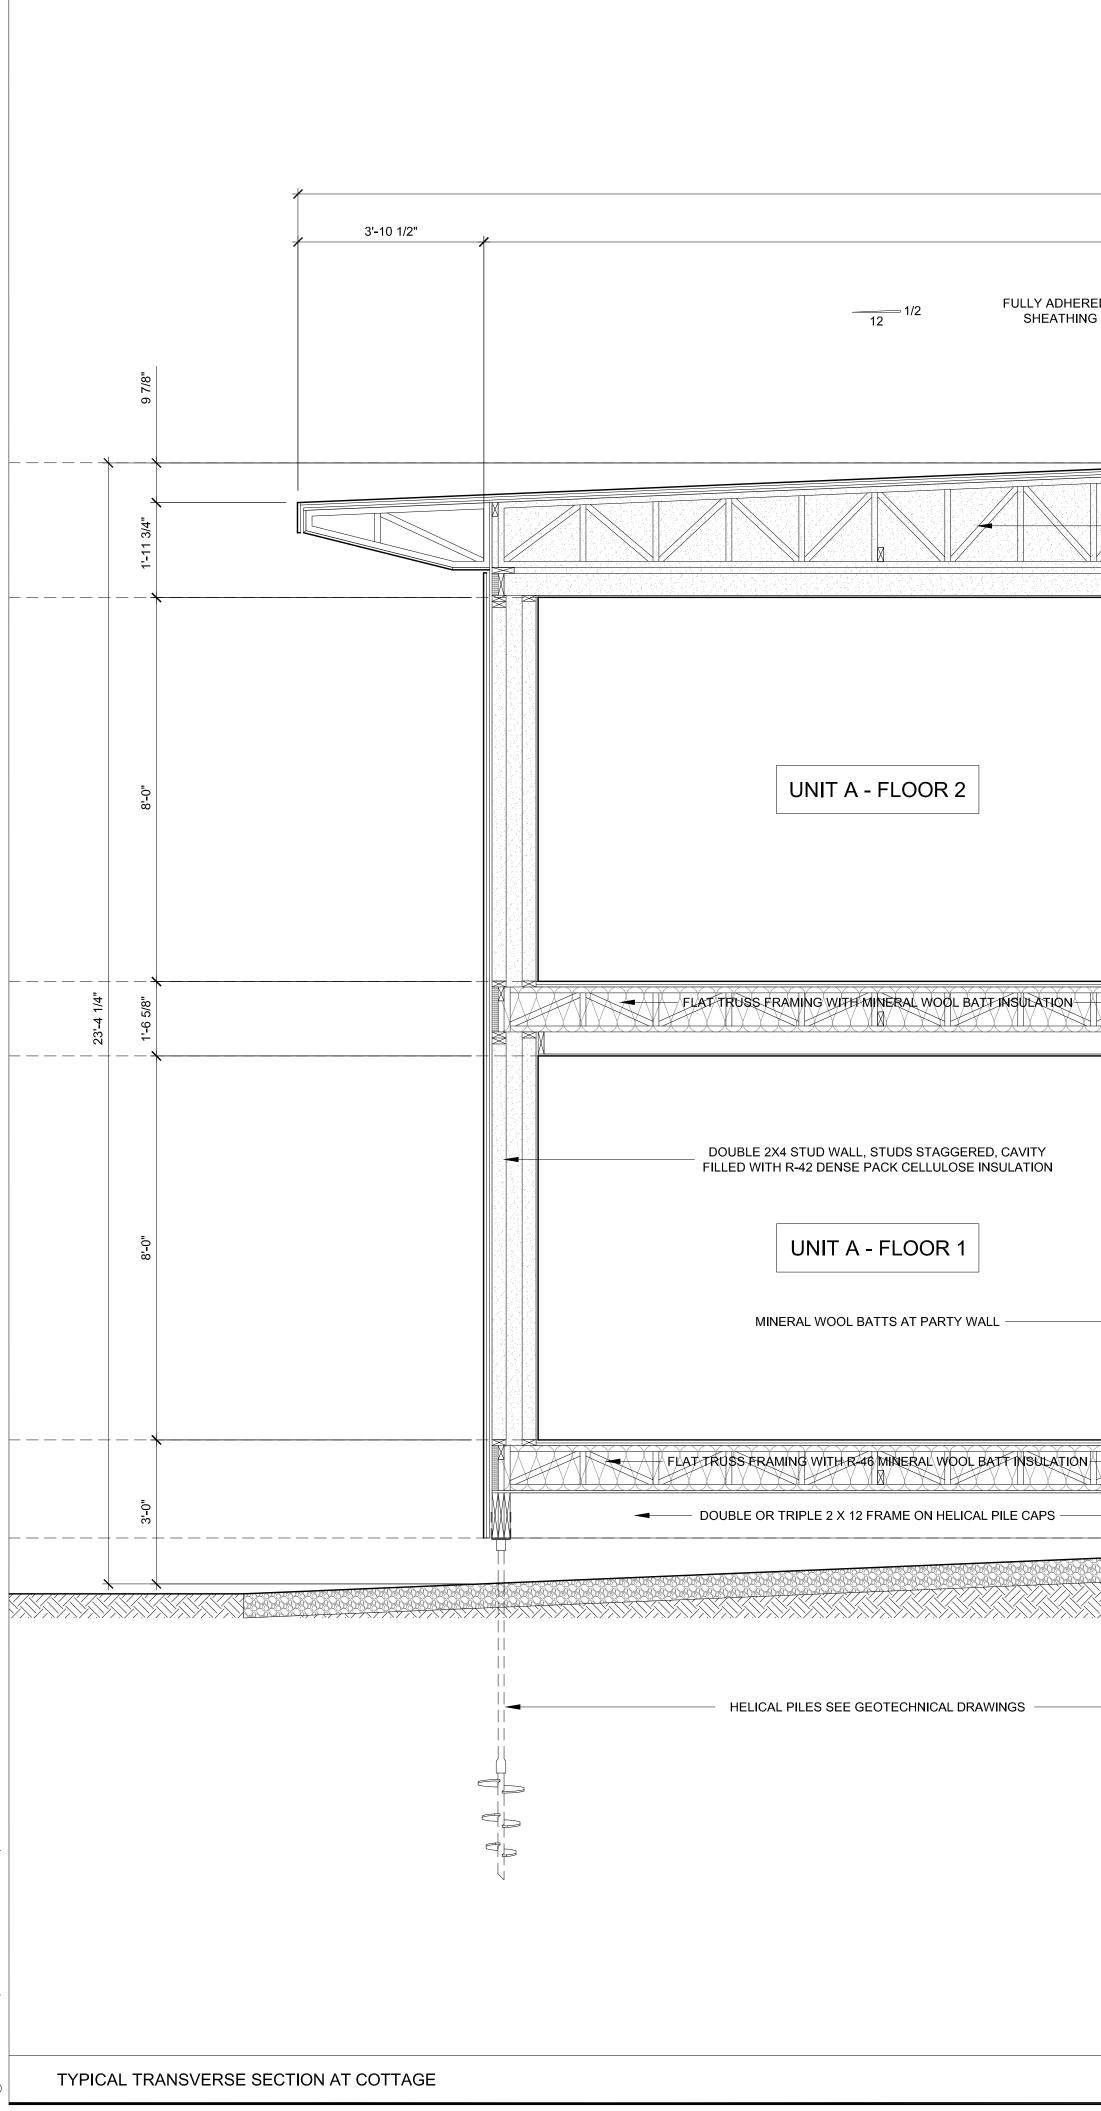

39'-10"	
32'-1" ED MEMBRANE ROOF ON 5/8" SHEATHING ON 3/4" FURRING ON 5/8" G ON PREFABRICATED WOOD TRUSSES, SPACED AS REQUIRED	TYPICAL COLD ROOF ASSEME SINGLE-PLY PVC MEMBRANE 5/8" OSB SHEATHING 3/4" FURRING STRIPS 5/8" TAPED SHEATHING AND A DENSE-PACK CELLULOSE INS PREFABRICATED WOOD TRUS 5/8" GYPSUM WALL BOARD
DENSE PACK CELLULOSE, MINIMUM R-57	
UNIT B - FLOOR 2	TYPICAL WALL ASSEMBLY CORRUGATED STEEL PANELS 3/4" FURRING STRIPS #15 BUILDING FELT 5/8" TAPED SHEATHING AND A 2X4 STUDS AT 16" O.C. DENSE-PACK CELLULOSE INS 2X4 STUDS AT 24" O.C. 5/8" GYPSUM WALL BOARD
UNIT B - FLOOR 1	TYPICAL FLOOR ASSEMBLY - 5/8" TAPED SHEATHING AND A PREFABRICATED WOOD TRUS 11" MINERAL WOOL BATT INSU 5/8" PLYWOOD SUBFLOOR (AD 3/4" OAK STRIP FLOORING
BERM AREA UNDER COTTAGE, COMPACT AND PITCH 1/2" PER FOOT TO PERIMETER FOR DRAINAGE COVER WITH GEOTEXTILE FABRIC AND OVERLAY WITH 6" GRAVEL	

TYPICAL COLD ROOF ASSEMBLY – MINIMUM TOTAL R-VALUE 59

SINGLE-PLY PVC MEMBRANE ROOF (SIKA SARNAFIL) 5/8" OSB SHEATHING

5/8" TAPED SHEATHING AND AIR BARRIER SYSTEM (ZIP) DENSE-PACK CELLULOSE INSULATION - MINIMUM 15" PREFABRICATED WOOD TRUSSES, SPACING TO BE DETERMINED 5/8" GYPSUM WALL BOARD

TYPICAL WALL ASSEMBLY -- TOTAL R-VALUE 44

CORRUGATED STEEL PANELS, FLUROPOLYMER FINISH 3/4" FURRING STRIPS #15 BUILDING FELT

5/8" TAPED SHEATHING AND AIR BARRIER SYSTEM (ZIP) 2X4 STUDS AT 16" O.C. DENSE-PACK CELLULOSE INSULATION - 11" FOR R-42 2X4 STUDS AT 24" O.C. 5/8" GYPSUM WALL BOARD

TYPICAL FLOOR ASSEMBLY – TOTAL R-VALUE 49 5/8" TAPED SHEATHING AND AIR BARRIER SYSTEM (ZIP)

PREFABRICATED WOOD TRUSSES AT 16" O.C. 11" MINERAL WOOL BATT INSULATION - R-46 5/8" PLYWOOD SUBFLOOR (ADVANTECH) 3/4" OAK STRIP FLOORING

No. Revision

GREEN RIVER COTTAGES

584 WATER STREET WILLIAMSTOWN, MA

ISSUED FOR REVIEW ONLY

Architect Stone Architecture, LLC 160 Water Street Williamstown, MA 01267 212.645.0635 Tel 212.645.1282 Fax

Drawing Title

TYPICAL TRANSVERSE SECTION

Drawn By Approved By		A-103	
Date	AUGUST 3, 2022	Scale	1/2" = 1'-0"

SCALE - 1/2" = 1'-0" 1



HISTORIC WILLIAMSTOWN GRANGE HALL – RENOVATED AS 5 GROUP 2B FULLY ACCESSIBLE DWELLING UNITS OF WHICH 3 ARE AFFORDABLE.



DWELLING UNIT SUMMARY

UNIT 1 -- TWO BEDROOM -- 1,244 NET SQUARE FEET UNIT 2 – ONE BEDROOM -- 684 NET SQUARE FEET



GREEN RIVER

Date

584 WATER STREET WILLIAMSTOWN, MA

ISSUED FOR REVIEW ONLY

Architect Stone Architecture, LLC 160 Water Street Williamstown, MA 01267 212.645.0635 Tel 212.645.1282 Fax

No. Revision

GRANGE HALL FIRST FLOOR PLAN

Drawing Title

Drawn By		٨	4 ^ 4
Approved By		A	-104
Issued For	REVIEW	Drawing No.	
Date	AUGUST 3, 2022	Scale	1/4" = 1'-0"

SCALE - 1/4" = 1'-0" 1







UNIT 3 -- ONE BEDROOM – 844 NET SQUARE FEET UNIT 4 – TWO BEDROOM – 844 NET SQUARE FEET UNIT 5 – STUDIO – 404 NSF



GREEN RIVER cottages

Date

584 WATER STREET WILLIAMSTOWN, MA

ISSUED FOR REVIEW ONLY

Architect Stone Architecture, LLC 160 Water Street Williamstown, MA 01267 212.645.0635 Tel 212.645.1282 Fax

No. Revision

GRANGE HALL SECOND FLOOR PLAN

Drawing Title

Drawn By		Α	4 0 E
Approved By		A-105	
Issued For	REVIEW	Drawing No.	
Date	AUGUST 3, 2022	Scale	1/4" = 1'-0"

SCALE - 1/4" = 1'-0" 1